


SOIL EROSION AND SEDIMENT CONTROL PLAN
SCALE 1:400

GENERAL NOTES:

- THIS PLAN IS A CONCEPT PLAN ONLY FOR CONSTRUCTION SEDIMENT & EROSION CONTROL. IT IS NOT SUITABLE FOR CONSTRUCTION. THIS PLAN SHOULD BE ADAPTED BY THE BUILDER DURING DEMOLITION, EXCAVATION & CONSTRUCTION PHASES TO ENSURE ADEQUATE PERFORMANCE.
- ALL DRAINAGE LAYOUT & DETAILS ARE DIAGRAMMATIC & INDICATIVE ONLY. ACTUAL LOCATION, SIZES, LEVELS & GRADES MAY LATER WHEN DETAIL DESIGN WORKS ARE DOCUMENTED.

EROSION & SEDIMENTATION CONTROL NOTES

- CONTRACTOR SHALL PROVIDE SEDIMENT FENCING MATERIAL DURING CONSTRUCTION TO THE LOW SIDE OF THE WORKS. TIE SEDIMENT FENCING MATERIAL TO CYCLONE WIRE SECURITY FENCE. SEDIMENT CONTROL FABRIC SHALL BE AN APPROVED MATERIAL (EG. HUMES PROPEX SILT STOP) STANDING 300mm ABOVE GROUND & EXTENDING 150mm BELOW GROUND.
- EXISTING DRAINS LOCATED WITHIN THE SITE SHALL ALSO BE ISOLATED BY SEDIMENT FENCING MATERIAL.
- NO PARKING OR STOCKPILING OF MATERIAL IS PERMITTED ON THE LOWER SIDE OF THE SEDIMENT FENCE.
- GRASS VERGES SHALL BE MAINTAINED AS MUCH AS PRACTICAL TO PROVIDE A BUFFER ZONE TO THE CONSTRUCTION SITE.
- CONSTRUCTION ENTRY/EXIT SHALL BE VIA THE LOCATION NOTED ON THE DRAWING. CONTRACTOR SHALL ENSURE ALL DROPPABLE SOIL & SEDIMENT IS REMOVED PRIOR TO CONSTRUCTION TRAFFIC EXITING SITE. CONTRACTOR SHALL ENSURE ALL CONSTRUCTION TRAFFIC ENTERING & LEAVING THE SITE DO SO IN A FORWARD DIRECTION.
- MAINTENANCE AND AUDITING OF SEDIMENT AND EROSION CONTROL IN ACCORDANCE WITH THE BLUE BOOK AND ANY RELEVANT CONSENT CONDITIONS.
- LOW POINTS OF EXCAVATION SHALL BE PUMPED TO THE SEDIMENT BASIN WHERE PROVIDED.
- PROVIDE WIND, AND DUST CONTROL IN ACCORDANCE WITH THE BLUE BOOK.
- PROVIDE BUNDS AND CATCH DRAINS AT THE TOP OF ALL BATTERS SO BATTERS ARE NOT ERODED WITH OVERLAND FLOW STORMWATER RUNOFF.

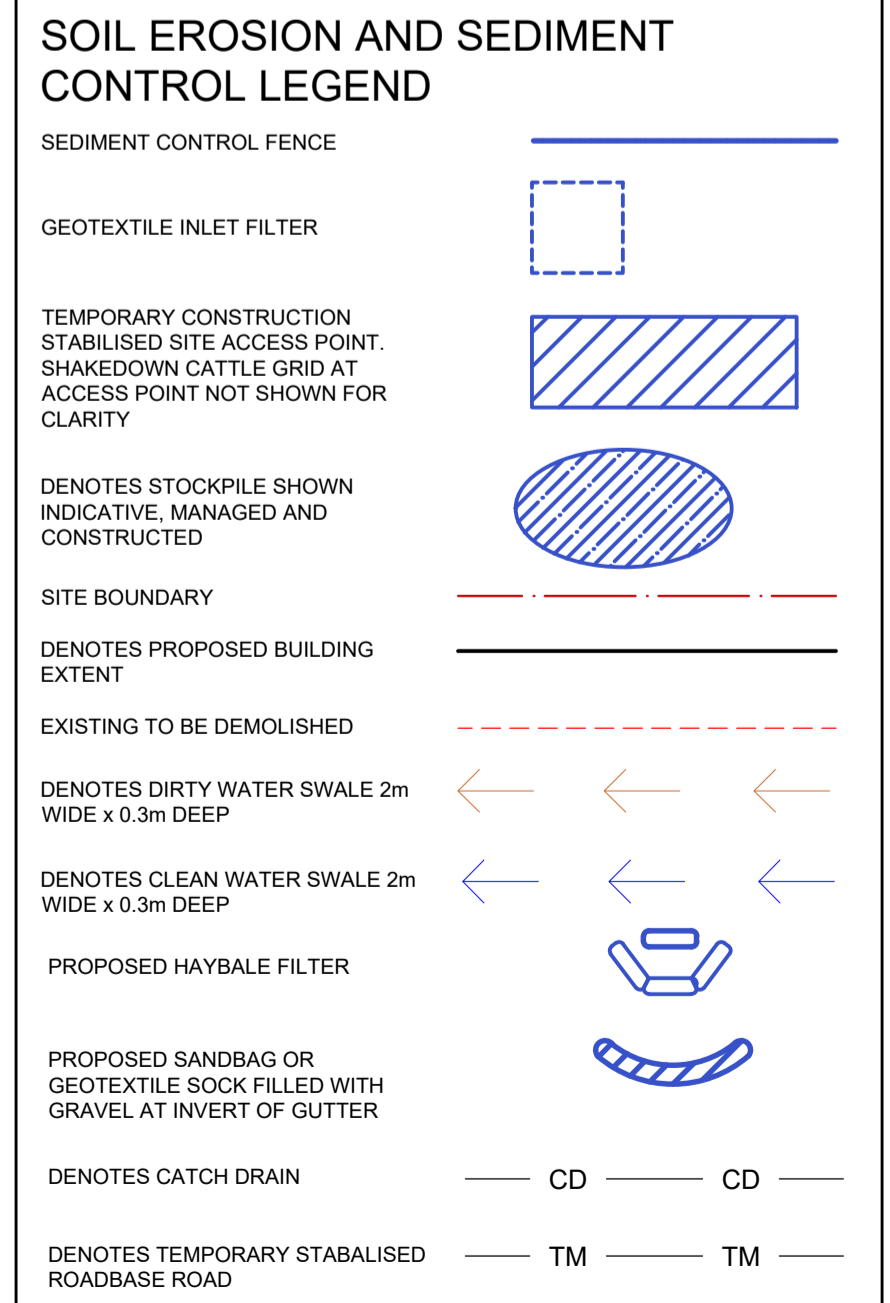

PRELIMINARY ISSUE
NOT FOR CONSTRUCTION

| ISSUE | DESCRIPTION | APPROVED | DATE |
|-------|-------------------------------|----------|----------|
| P1 | FOR COUNCIL ENDORSEMENT ISSUE | | 29.08.24 |

ARCHITECT
PMDL ARCHITECTURE INTERIORS MASTERPLANNING
PMDL ARCHITECTURE + DESIGN PTY LTD ABN 66 006 181 217
NSW NOMINATED ARCHITECTS: ANDREW PENDER 2017 DAVID MORRIS 2005 VICKI VAN DIJK 2016

BIRZULIS ASSOCIATES
CONSULTING STRUCTURAL & CIVIL ENGINEERS
583 DARLING STREET ROZELLE NSW 2039
tel: (02) 9555 7230 email: office@birzulisassociates.com
www.birzulisassociates.com

PROJECT
WILLIAM CLARKE COLLEGE
10 MORRIS GROVE, KELLYVILLE
- BRYSON BUILDING

TITLE
SOIL EROSION AND SEDIMENT CONTROL PLAN

| SCALES | as noted @ A1 | DATE | AUG' 2024 |
|----------|---------------|----------|-----------|
| DRAWN | C.KE | DESIGN | GK/MG |
| VERIFIED | | APPROVED | |

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| ISSUE | PROJECT No. | DRAWING No. |
|-----------|-------------|-------------|
| P1 | 8932 | C.10 |

